



NOTE: SEAL ALL CURBS, JACKS, PITCH POCKETS AND OTHER PENETRATIONS PRIOR TO NEW ROOFING SYSTEM

TYPICAL MECHANICAL CURB CONDITION



TYPICAL JACK CONDITION

### **TYPICAL CURB, JACK, PITCH POCKET AND PENETRATIONS** 6 SCALE: NTS



NOTE: WHERE BUR SECTIONS TIE INTO TILE SECTIONS REMOVE ONE ROW OF TILE, APPLY NEW ROOFING MATERIAL AND REPLACE TILES.



Note: INSPECT EXISTING SKYLIGHT FLASHING WITH MANUFACTURER AND REPLACE PER MANUFACTURER'S RECOMMENDATION.



**TYPICAL VALLEY & SKYLIGHT** 




NOTE: INSPECT AND CLEAN DRAINS. IF DRAINS ARE IN POOR CONDITION AND NEED REPLACEMENT NOTIFY UNIVERSITY REPRESENTATIVE.

TYPICAL PENETRATION @ VERTICAL SURFACE



NOTE: WHERE BUR SECTIONS TIE INTO TILE SECTIONS REMOVE ONE ROW OF TILE, PATCH BUR ROOFING SYSTEM, APPLY NEW ROOFING MATERIAL AND REPLACE TILES.

TYPICAL BUR TO TILE ROOFING CONDITION

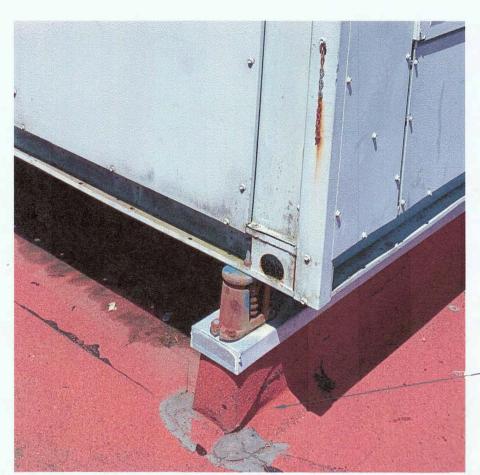




### **TYPICAL DRAIN & BUR AT TILE ROOFING** 4 SCALE: NTS




NOTE: REMOVE WOOD CATWALK SYSTEM AND INSTALL NEW ROOFTOP SUPPORTS FOR EXISTING UTILITIES. TYPICAL WOOD CATWALK

- EXISTING UTILITIES

2

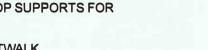




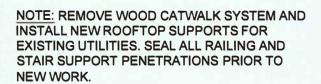

- TYPICAL WOOD CATWALK
- TYPICAL STAIR SUPPORT PENETRATION

- TYPICAL RAILING SUPPORT PENETRATION



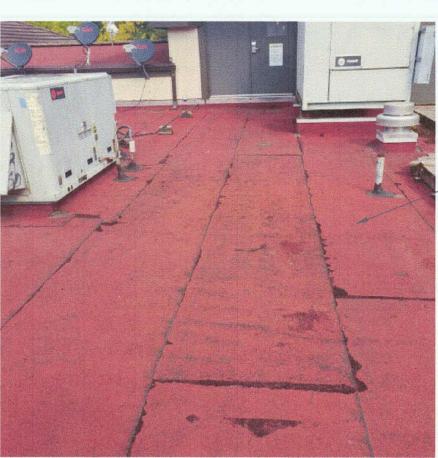



1 GENER SCALE: NTS

### **TYPICAL PLATFORM, RAILING/STAIR AND UTILITY CONDITIONS** 3 SCALE: NTS

- - - -

NOTE: SEAL EXISTING CURB PRIOR TO NEW ROOFING WORK.

- TYPICAL CURB AT MECHANICAL UNIT

# NOTE: REMOVE EXISTING ROOFTOP SUPPORTS AND REPLACE WITH DURA-BLOK SYSTEM, OR EQUAL.

TYPICAL WOOD ROOFTOP SUPPORT

# **TYPICAL CURB AND ROOFTOP SUPPORT**


NOTE: STUDENT ACTIVITY CENTER ROOF CONSISTS OF TWO ROOFING SYSTEMS. THE FIRST IS A BUILT-UP ROOF SYSTEM. THE SECOND IS A BALLASTED BUILT-UP ROOF SYSTEM.


TYPICAL BUILT-UP ROOFING SYSTEM


TYPICAL BALLASTED BUILT-UP ROOFING SYSTEM

**GENERAL ROOFING INFORMATION** 


IFB	#PW23-2 Exhibit F 5 of 10
	D
MANA 1 HARP ARCAT	ILITIES GEMENT ST STREET A, CA 95521 826-3646
SAC ROOF REPAIR	STUDENT ACTIVITIES CENTER (BLDG 045)
CONS DOC BUILDING PI This project has d with applicable established by sta Based on this doc 'APPROVED F Callfornia State Poly Date: Callfornia State Poly Date: SFM Approvals. SFM Approvals. SFM Approvals. SFM Approvals. SFM Approvals. SFM Approvals. DSA Access App Seismic Peer Re Other: DSA Access App Seismic Peer Re Other: CALIFORM MARSHA Approval of this p or approve any o applicable regula subject to field in approved plans s project she at all Reviewed by: PROJECT # W.O. #: DRAWN BY: SHE TY R CON PH	As applicable: proval: wiew: WIA STATE FIRE A APPROVED blan does not authorize mission or deviation from tions. Final approval is spection. One set of thall be available on the times. Y-MAC Y-MAC CKB E: APR. 07, 2022 ET TITLE PICAL OOF DITION OTOS SHEET
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	IFB #PW23-2 Exhibit F
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	FACILITIES MANAGEMENT
	1 HARPST STREET ARCATA, CA 95521
	707 826-3646
INDICATES LINE OF (E) WALL BELOW @ 2nd FLOOR	~ ()
INDICATES LINE OF (E) WALL BELOW (@ 210 FLOOR	PAIR + & GUTTER JNS EL NG
(E) HWS/R WATER LINES	<b>OF R</b> H & C(117 Wi H & C(2) 042)
	C ROOF R UTILITY H-EAST EN EALTH & (BLDG 04
(E) B.U.R. ROOF @ UTILITY WELL OF UPPER ROOF	<b>1 &amp; C ROOF RE</b> UPPER UTILITY WELL SOUTH-EAST ENTRY NT HEALTH & CO (BLDG 042)
	S H LOWER
	and the second second
	STATUS
(E) DOWNSPOUT, TYP.	CONSTRUCTION DOCUMENTS
(E) ACCESSIBLE ENTRY TO LOWER FLOOR BELOW;	BUILDING PERMIT APPROVAL This project has demonstrated
VERIFY EXTENT OF LOW SLOPE B.U.R. IN FIELD	conformance with applicable codes and standards established by statute and University policy. Based on this determination these docu 'APPROVED FUR CON TRUCTION'
	KASSIDYE. BANDUCCI
(E) EXPANSION JOINT, TYP.	Campus of Building Official California State P this University, Humboldt Date 22. Appl. 2011
	Permit #: <u>2021/22-013</u> Other approvals 'as applicable:- SFM Approval:
	DSA Access Approval: Seismic Peer Review: Other:
(E) B.U.R. ROOF @ LOW SLOPE OF LOWER ROOF - SOUTH-EAST ENTRY CANOPY	CALIFORNIA STATE FIRE MARSHAL APPROVED
en en ser en	Approval of this plan does not authorize or approve any omission or deviation fror applicable regulations. Final approval is subject to field inspection. One set of approved plans shall be available on the
	projection at all time.
(E) SHEET METAL GUTTER & FLASHING	Reviewed by: 42422 PROJECT #: XPL257
	W.O. #: DRAWN BY: CKB
	ISSUE DATE: APR. 07, 2022 REV:
VERIFY (E) PENETRATIONS IN FIELD	
<b>KEY TO EXISTING ROOF TYPES</b>	SHEET TITLE
	EXISTING
(E) BUILT-UP ROOFING	ROOF PLAN
NOTE: COLOR SHOWN IS INFORMATIONAL ONLY TO REFERENCE LOCATIONS OF EXISTING ROOF TYPE.	and it is a second second second
	SHEET A2.0

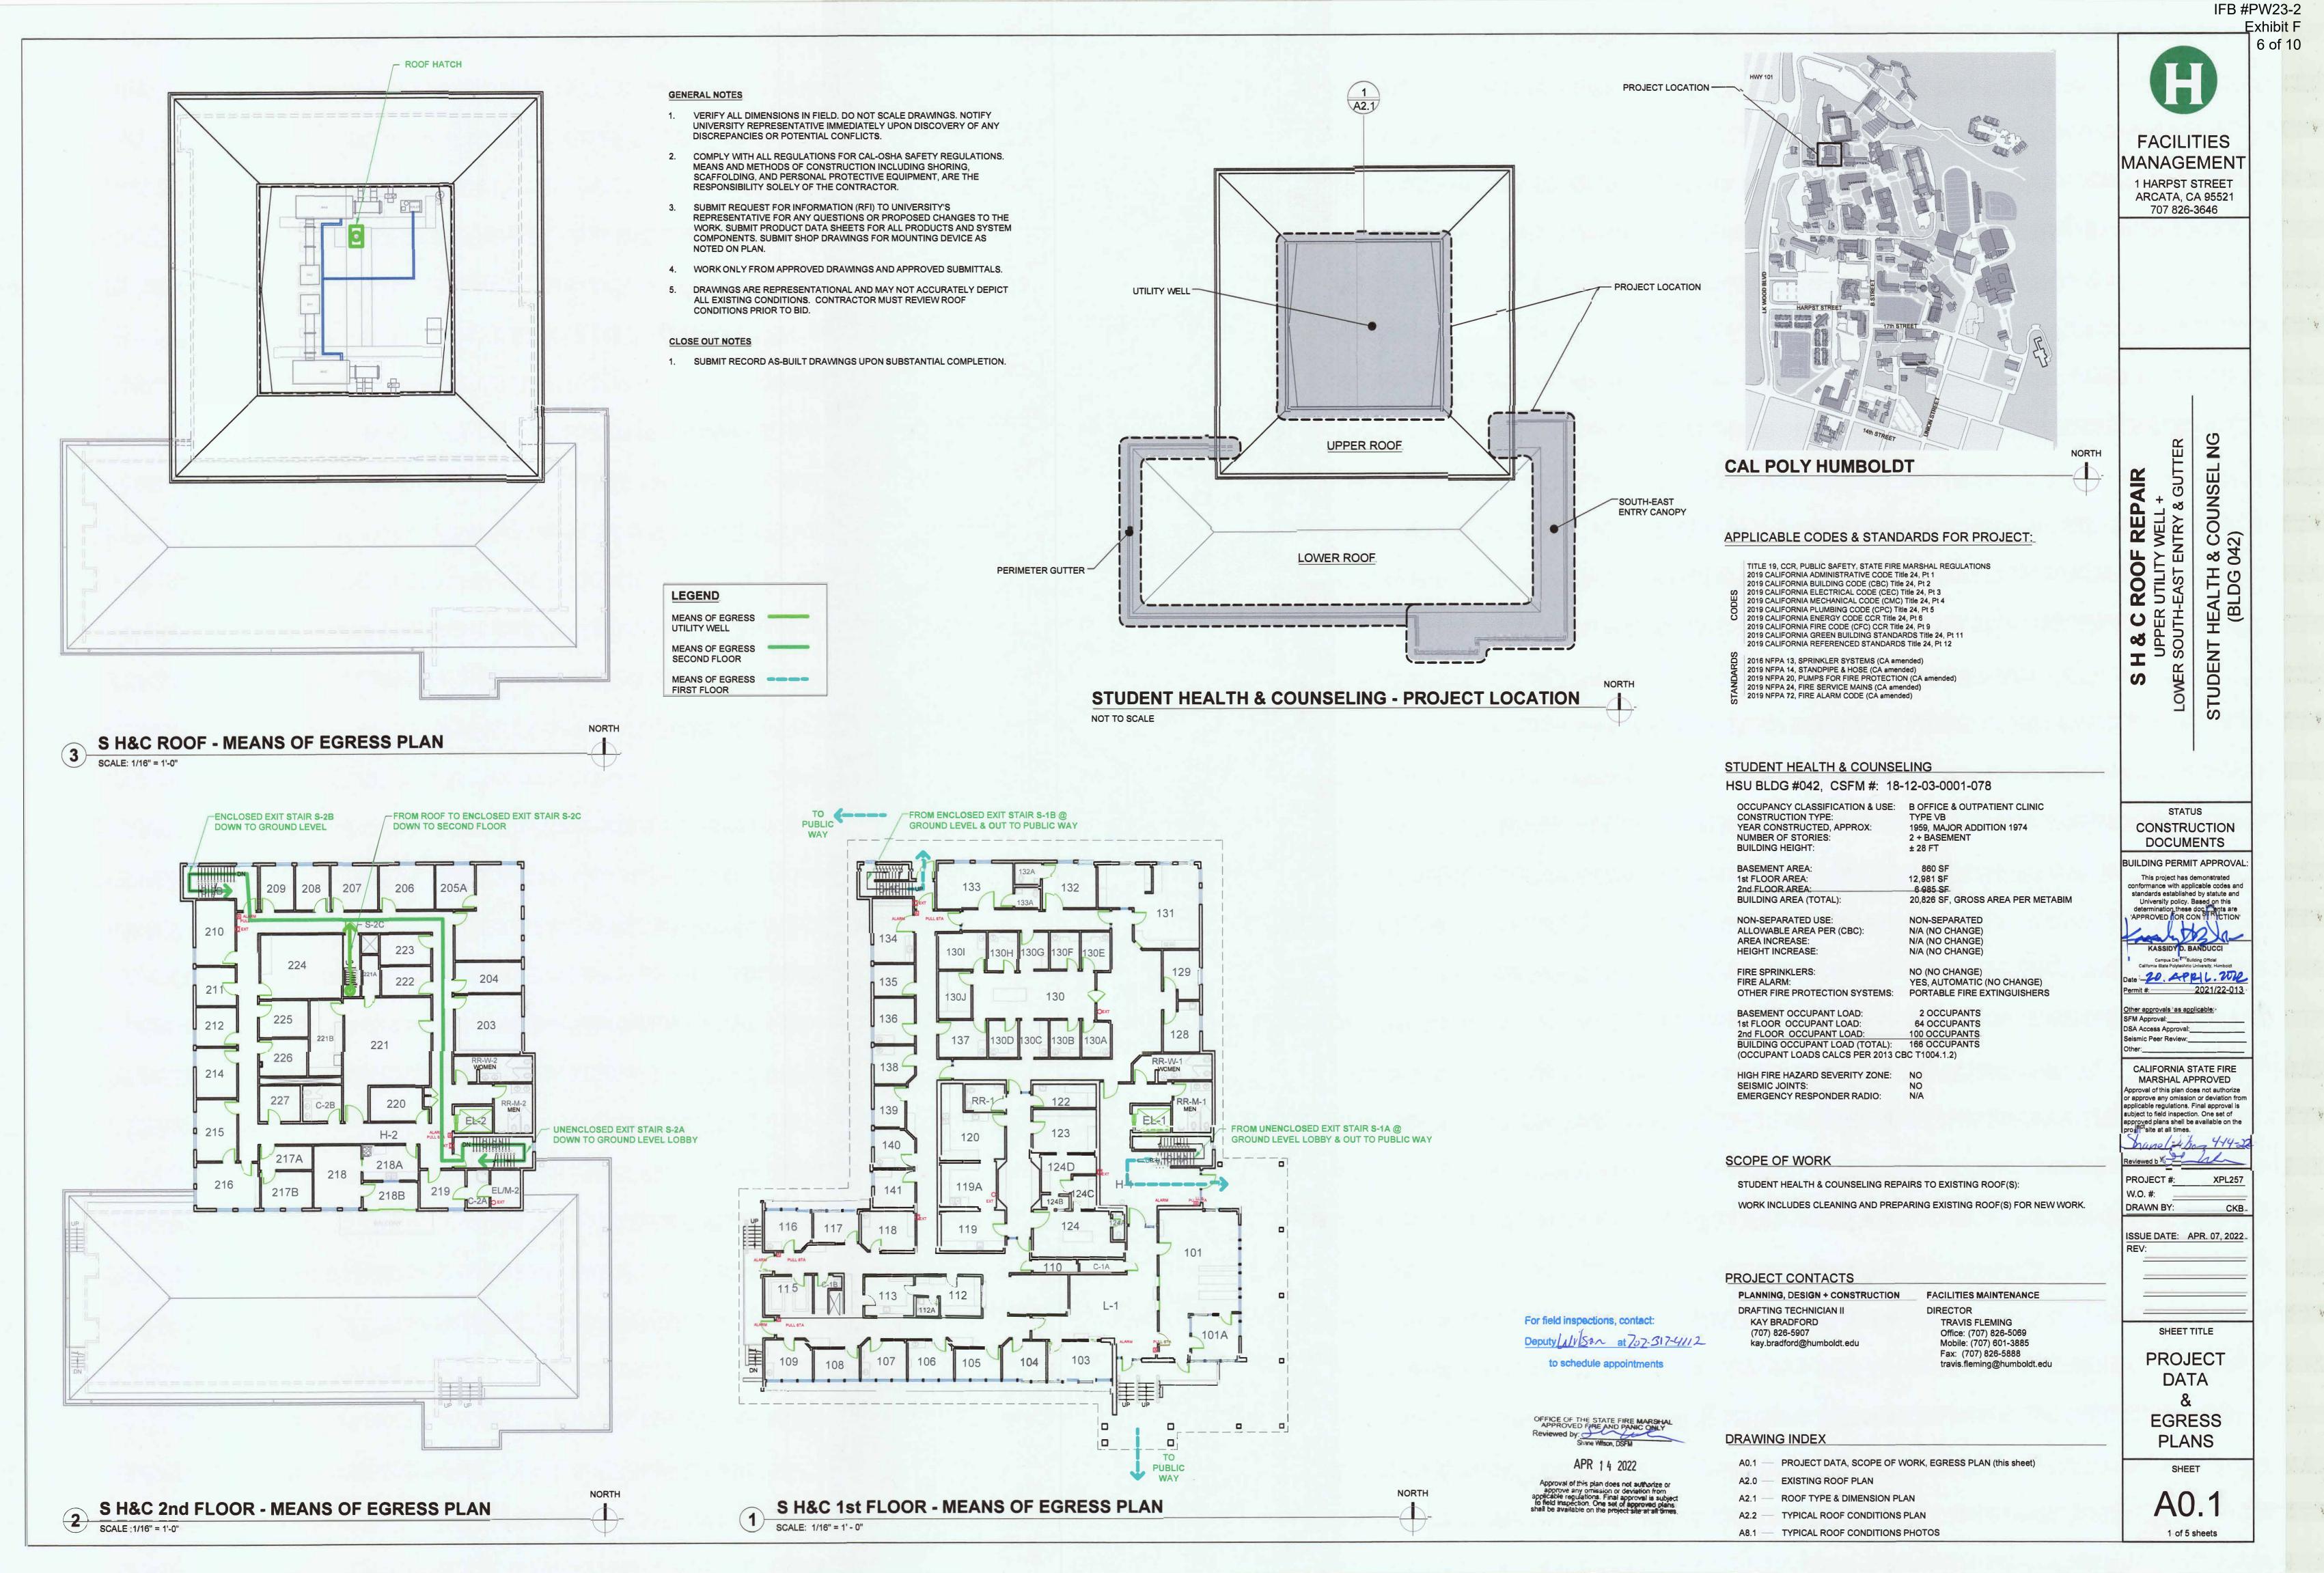
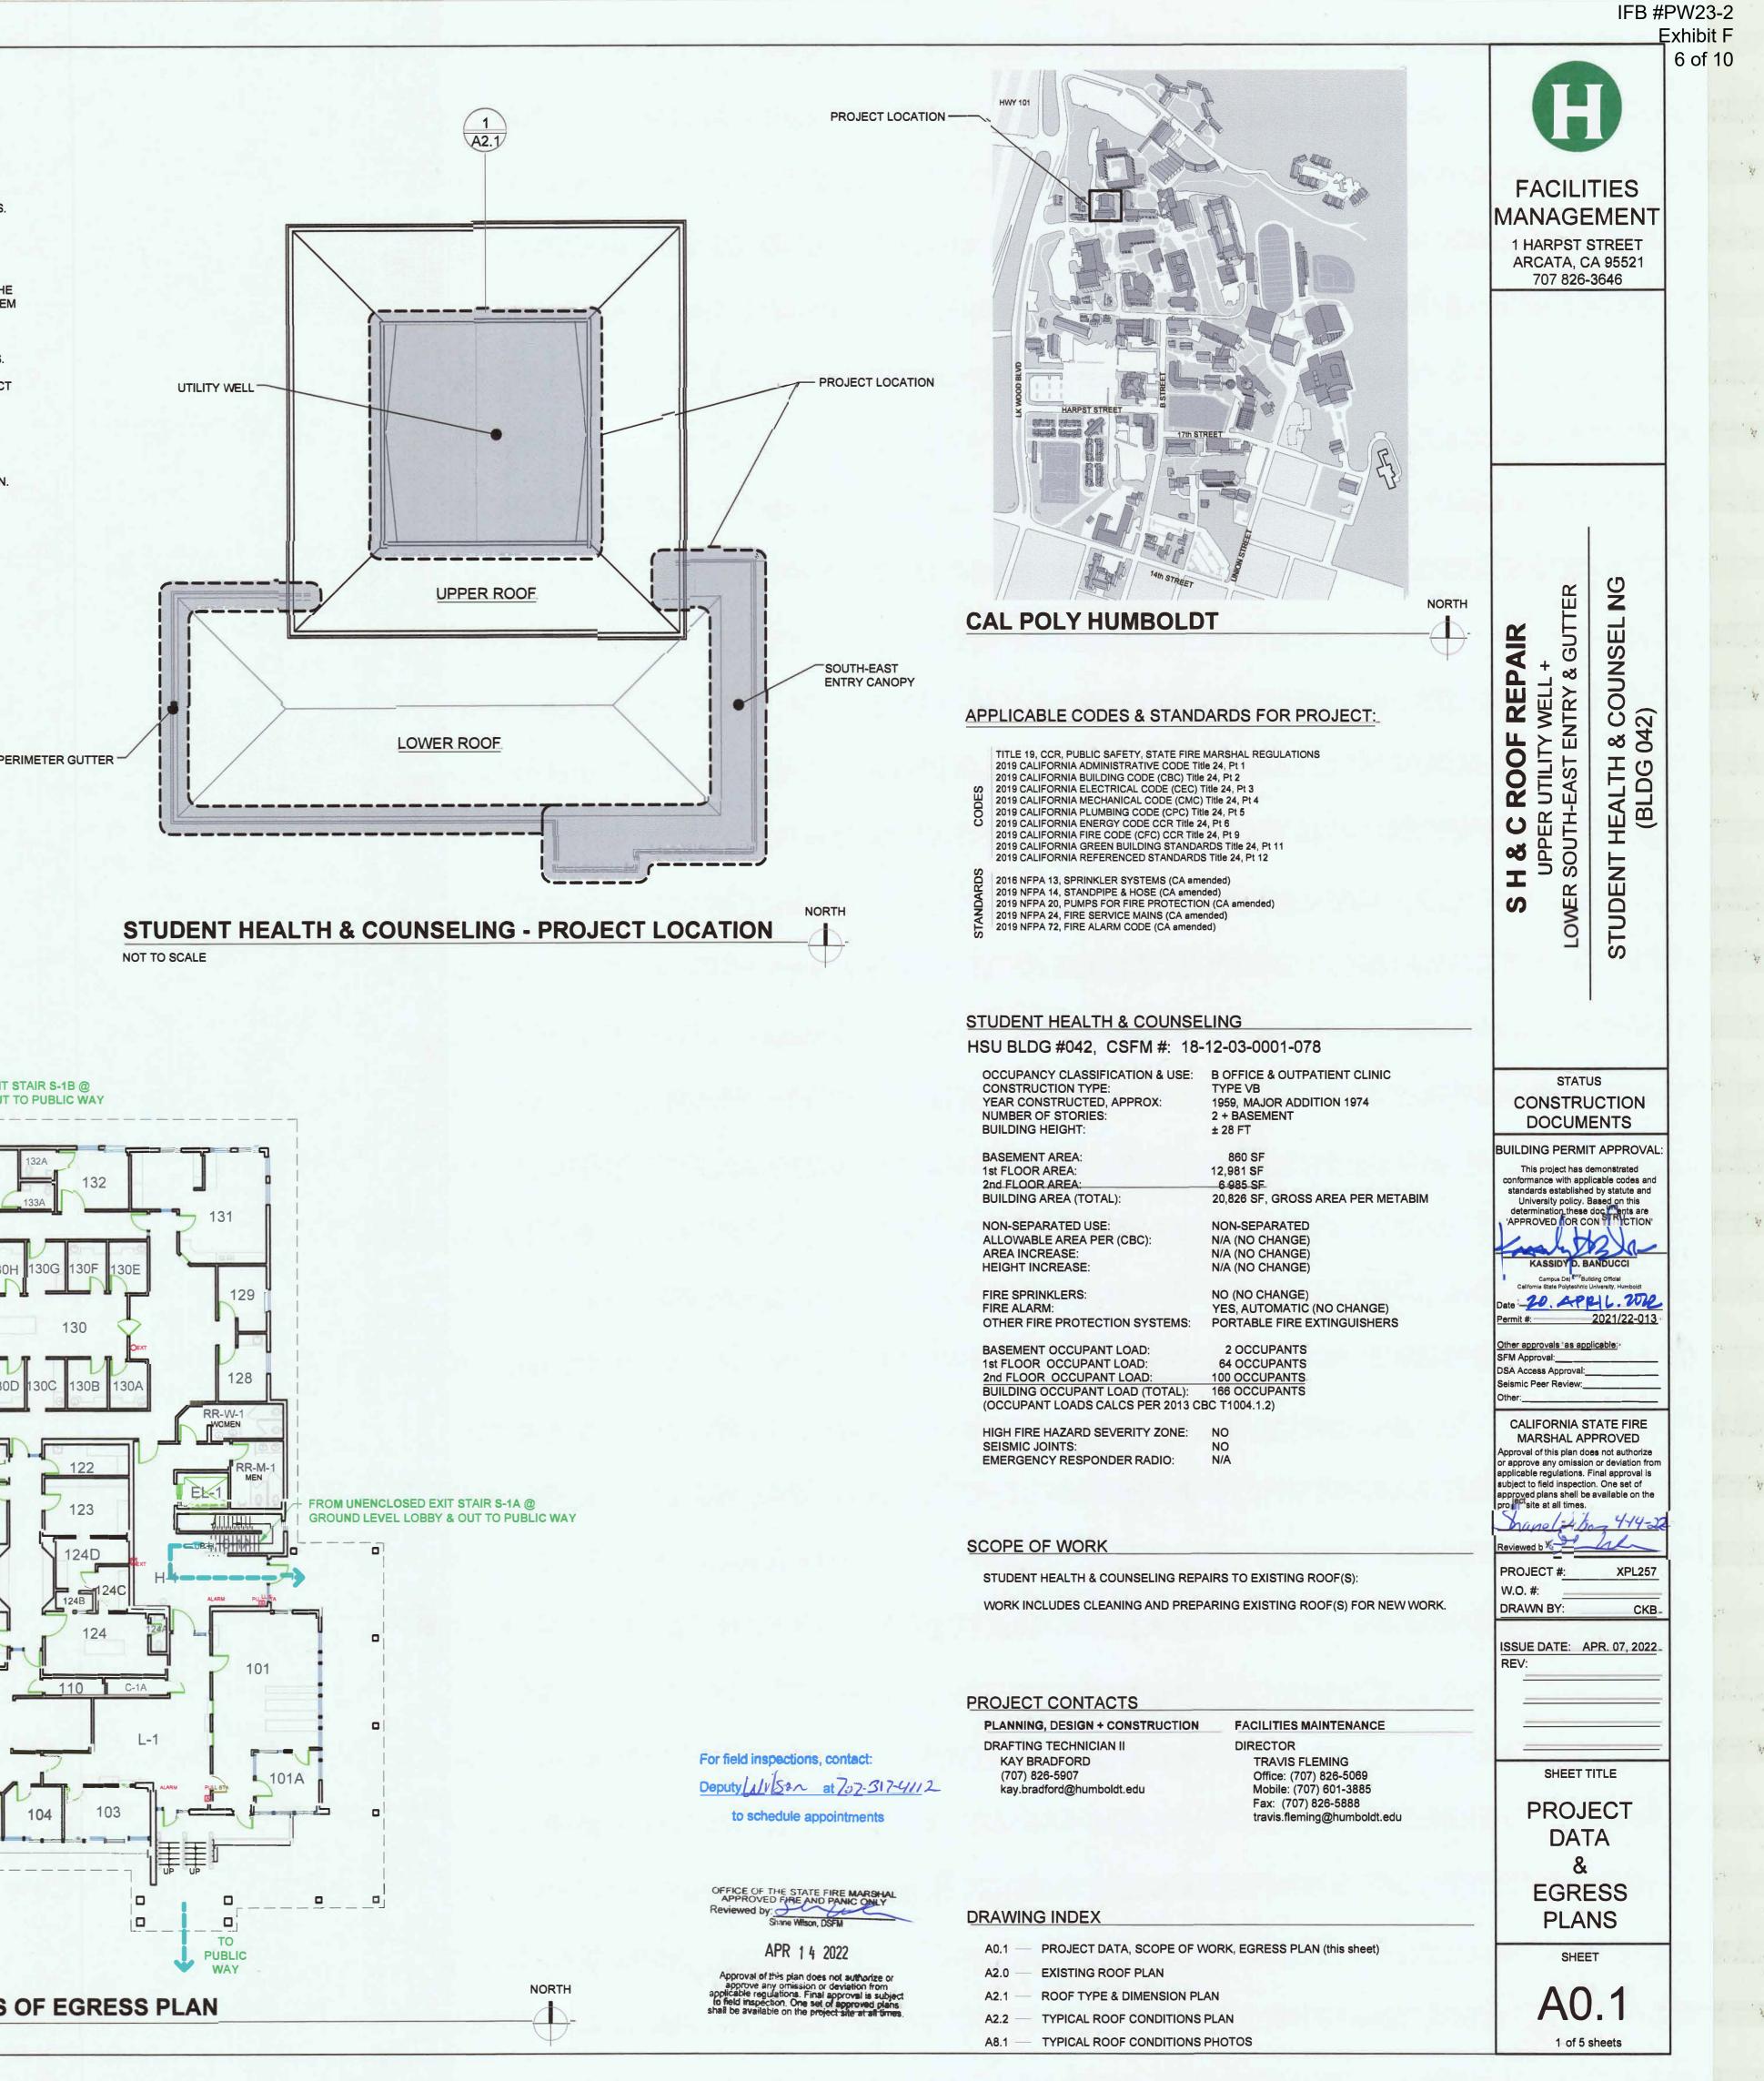
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STUDENT HEALTH & COUNSELING (BLDG 042)
S CTION ENTS APPROVAL: monstrated cable codes and by statute and ased on this locumenta are NSTRUCTION NDUCCI INDUCCI
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# **KEY TO PROPOSED ROOF TYPES**

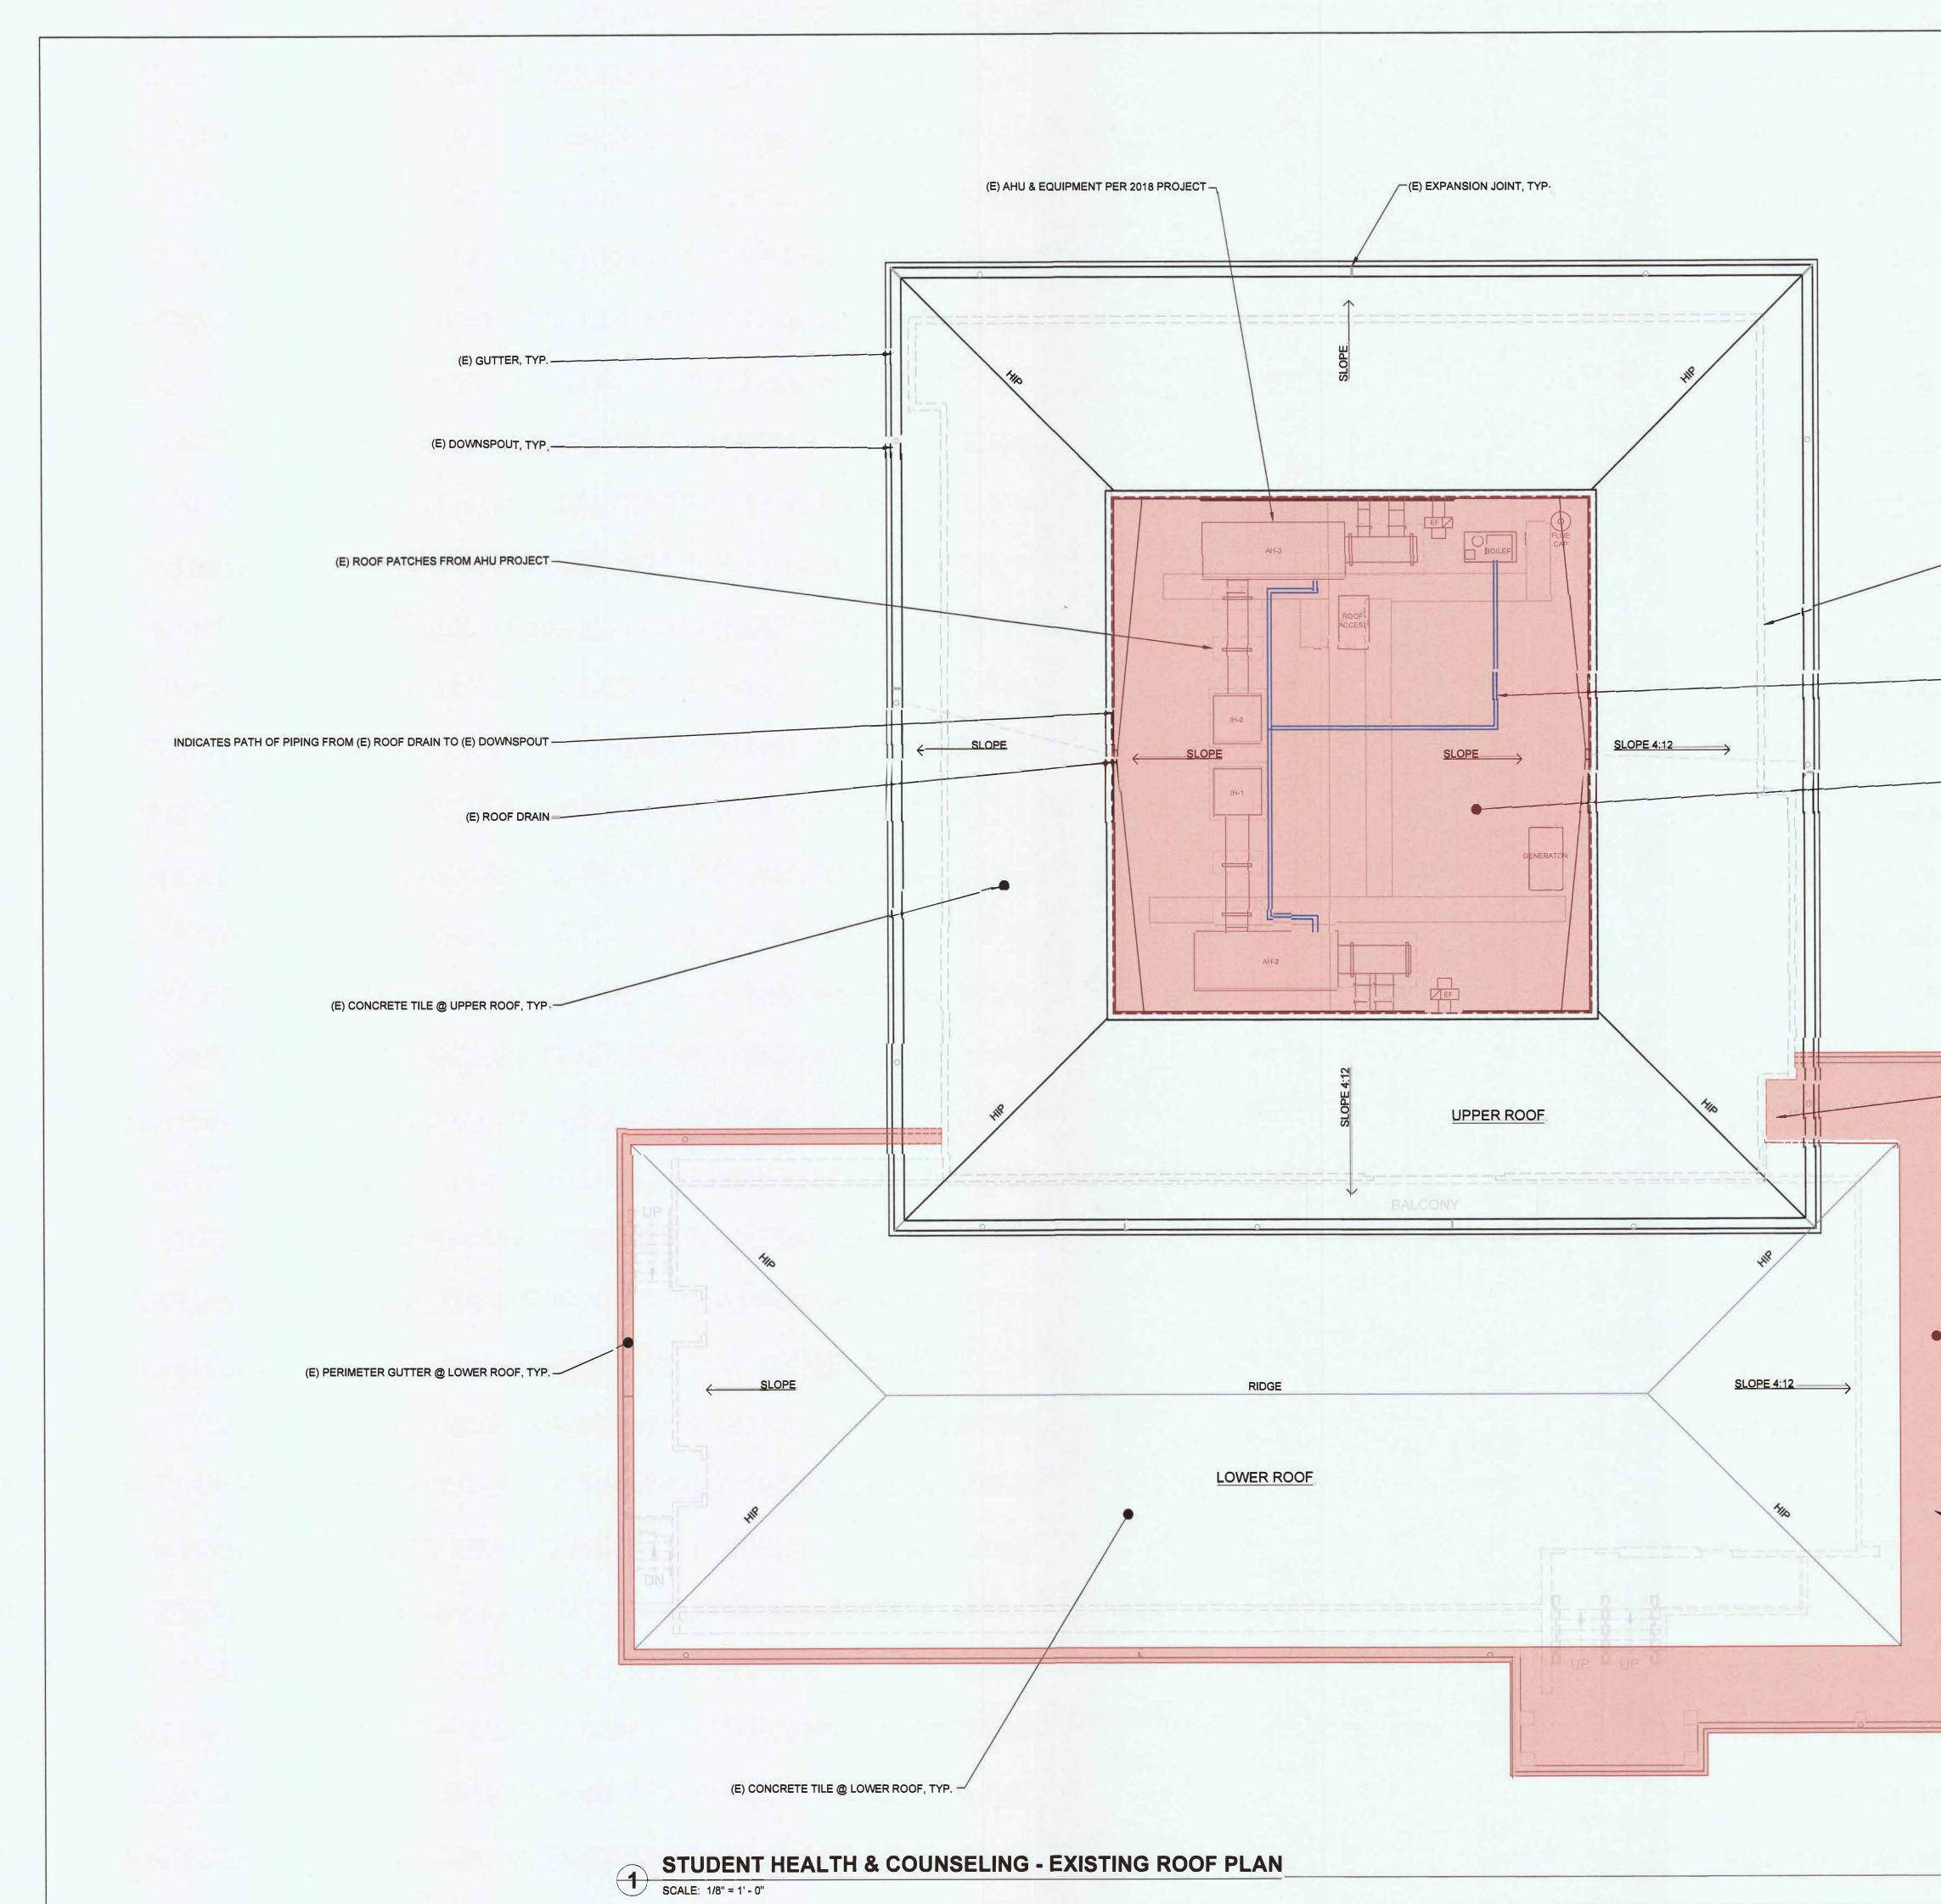NEW FLUID APPLIED ROOFING RESTORATION


NOTE: COLOR SHOWN IS INFORMATIONAL ONLY TO REFERENCE LOCATION OF PROPOSED ROOF TYPE. REFER TO WRITTEN SPECIFICATIONS / APPROVED SUBMITTALS FOR ACTUAL ROOFING MATERIAL COLOR.
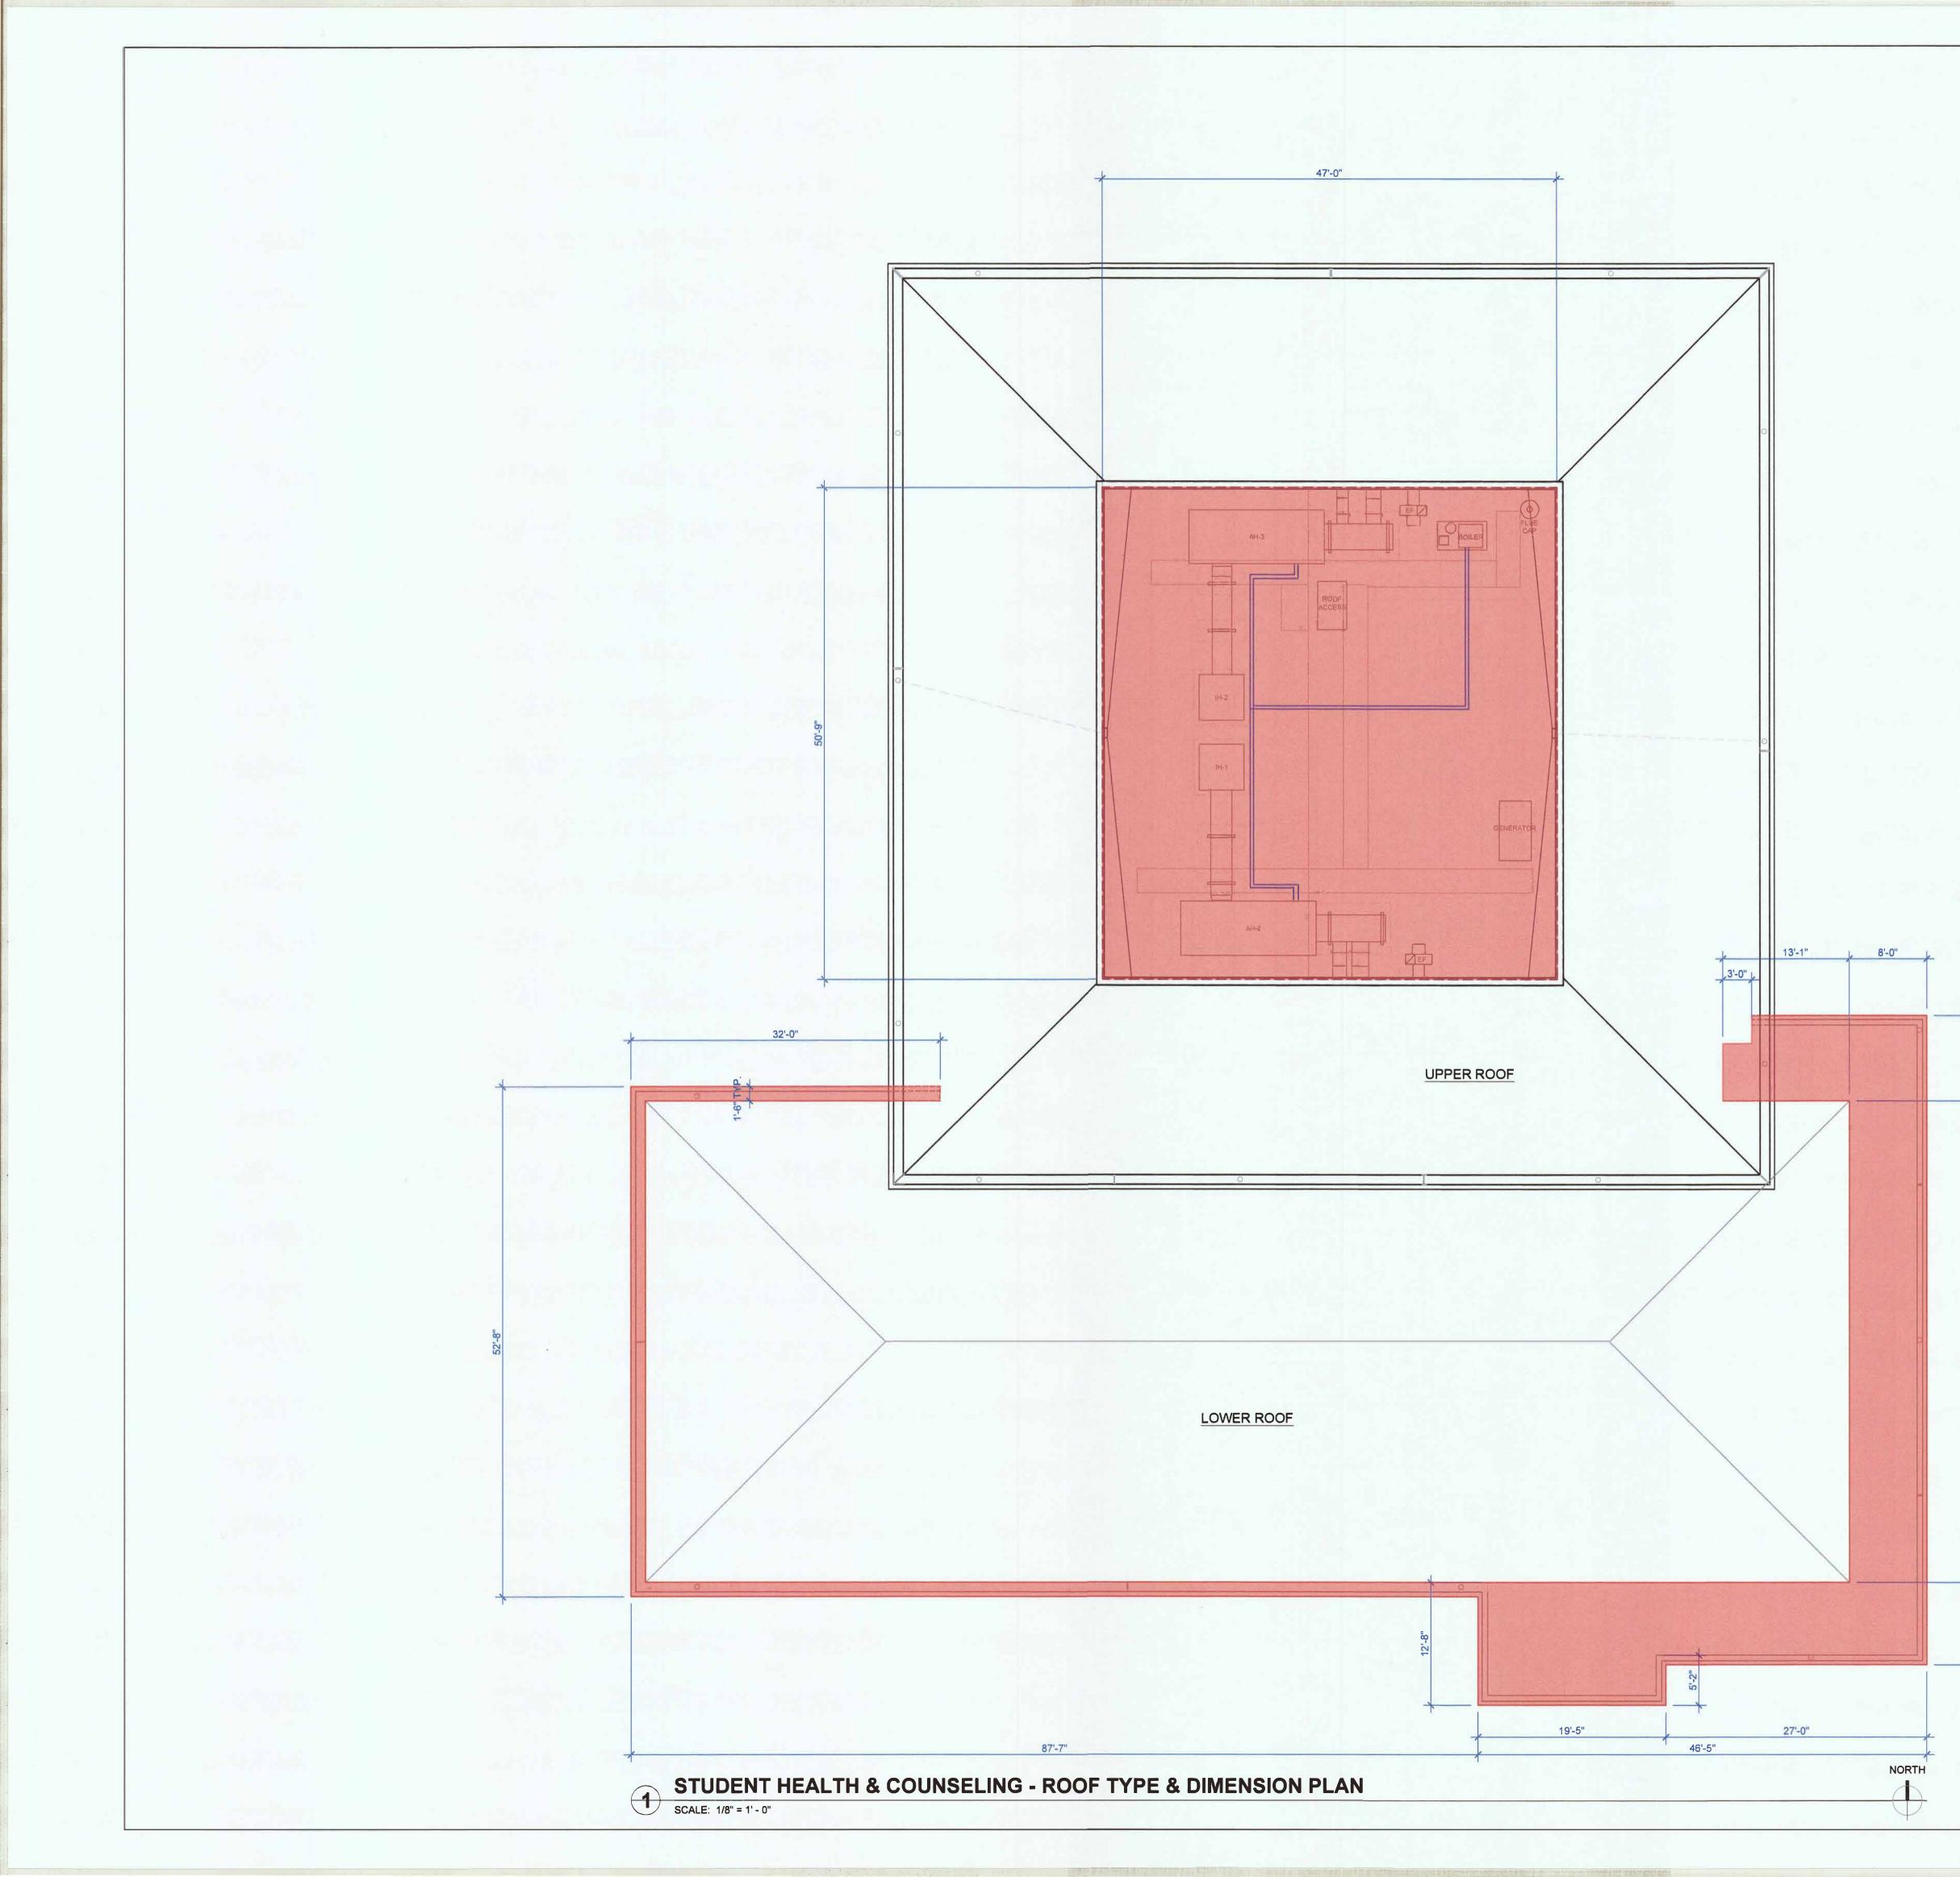
### ROOF PLAN NOTES

1. SEE PROJECT SPECIFICATIONS FOR MORE INFORMATION.

CLOSE OUT NOTES

1. SUBMIT RECORD AS-BUILT DRAWINGS UPON SUBSTANTIAL COMPLETION.

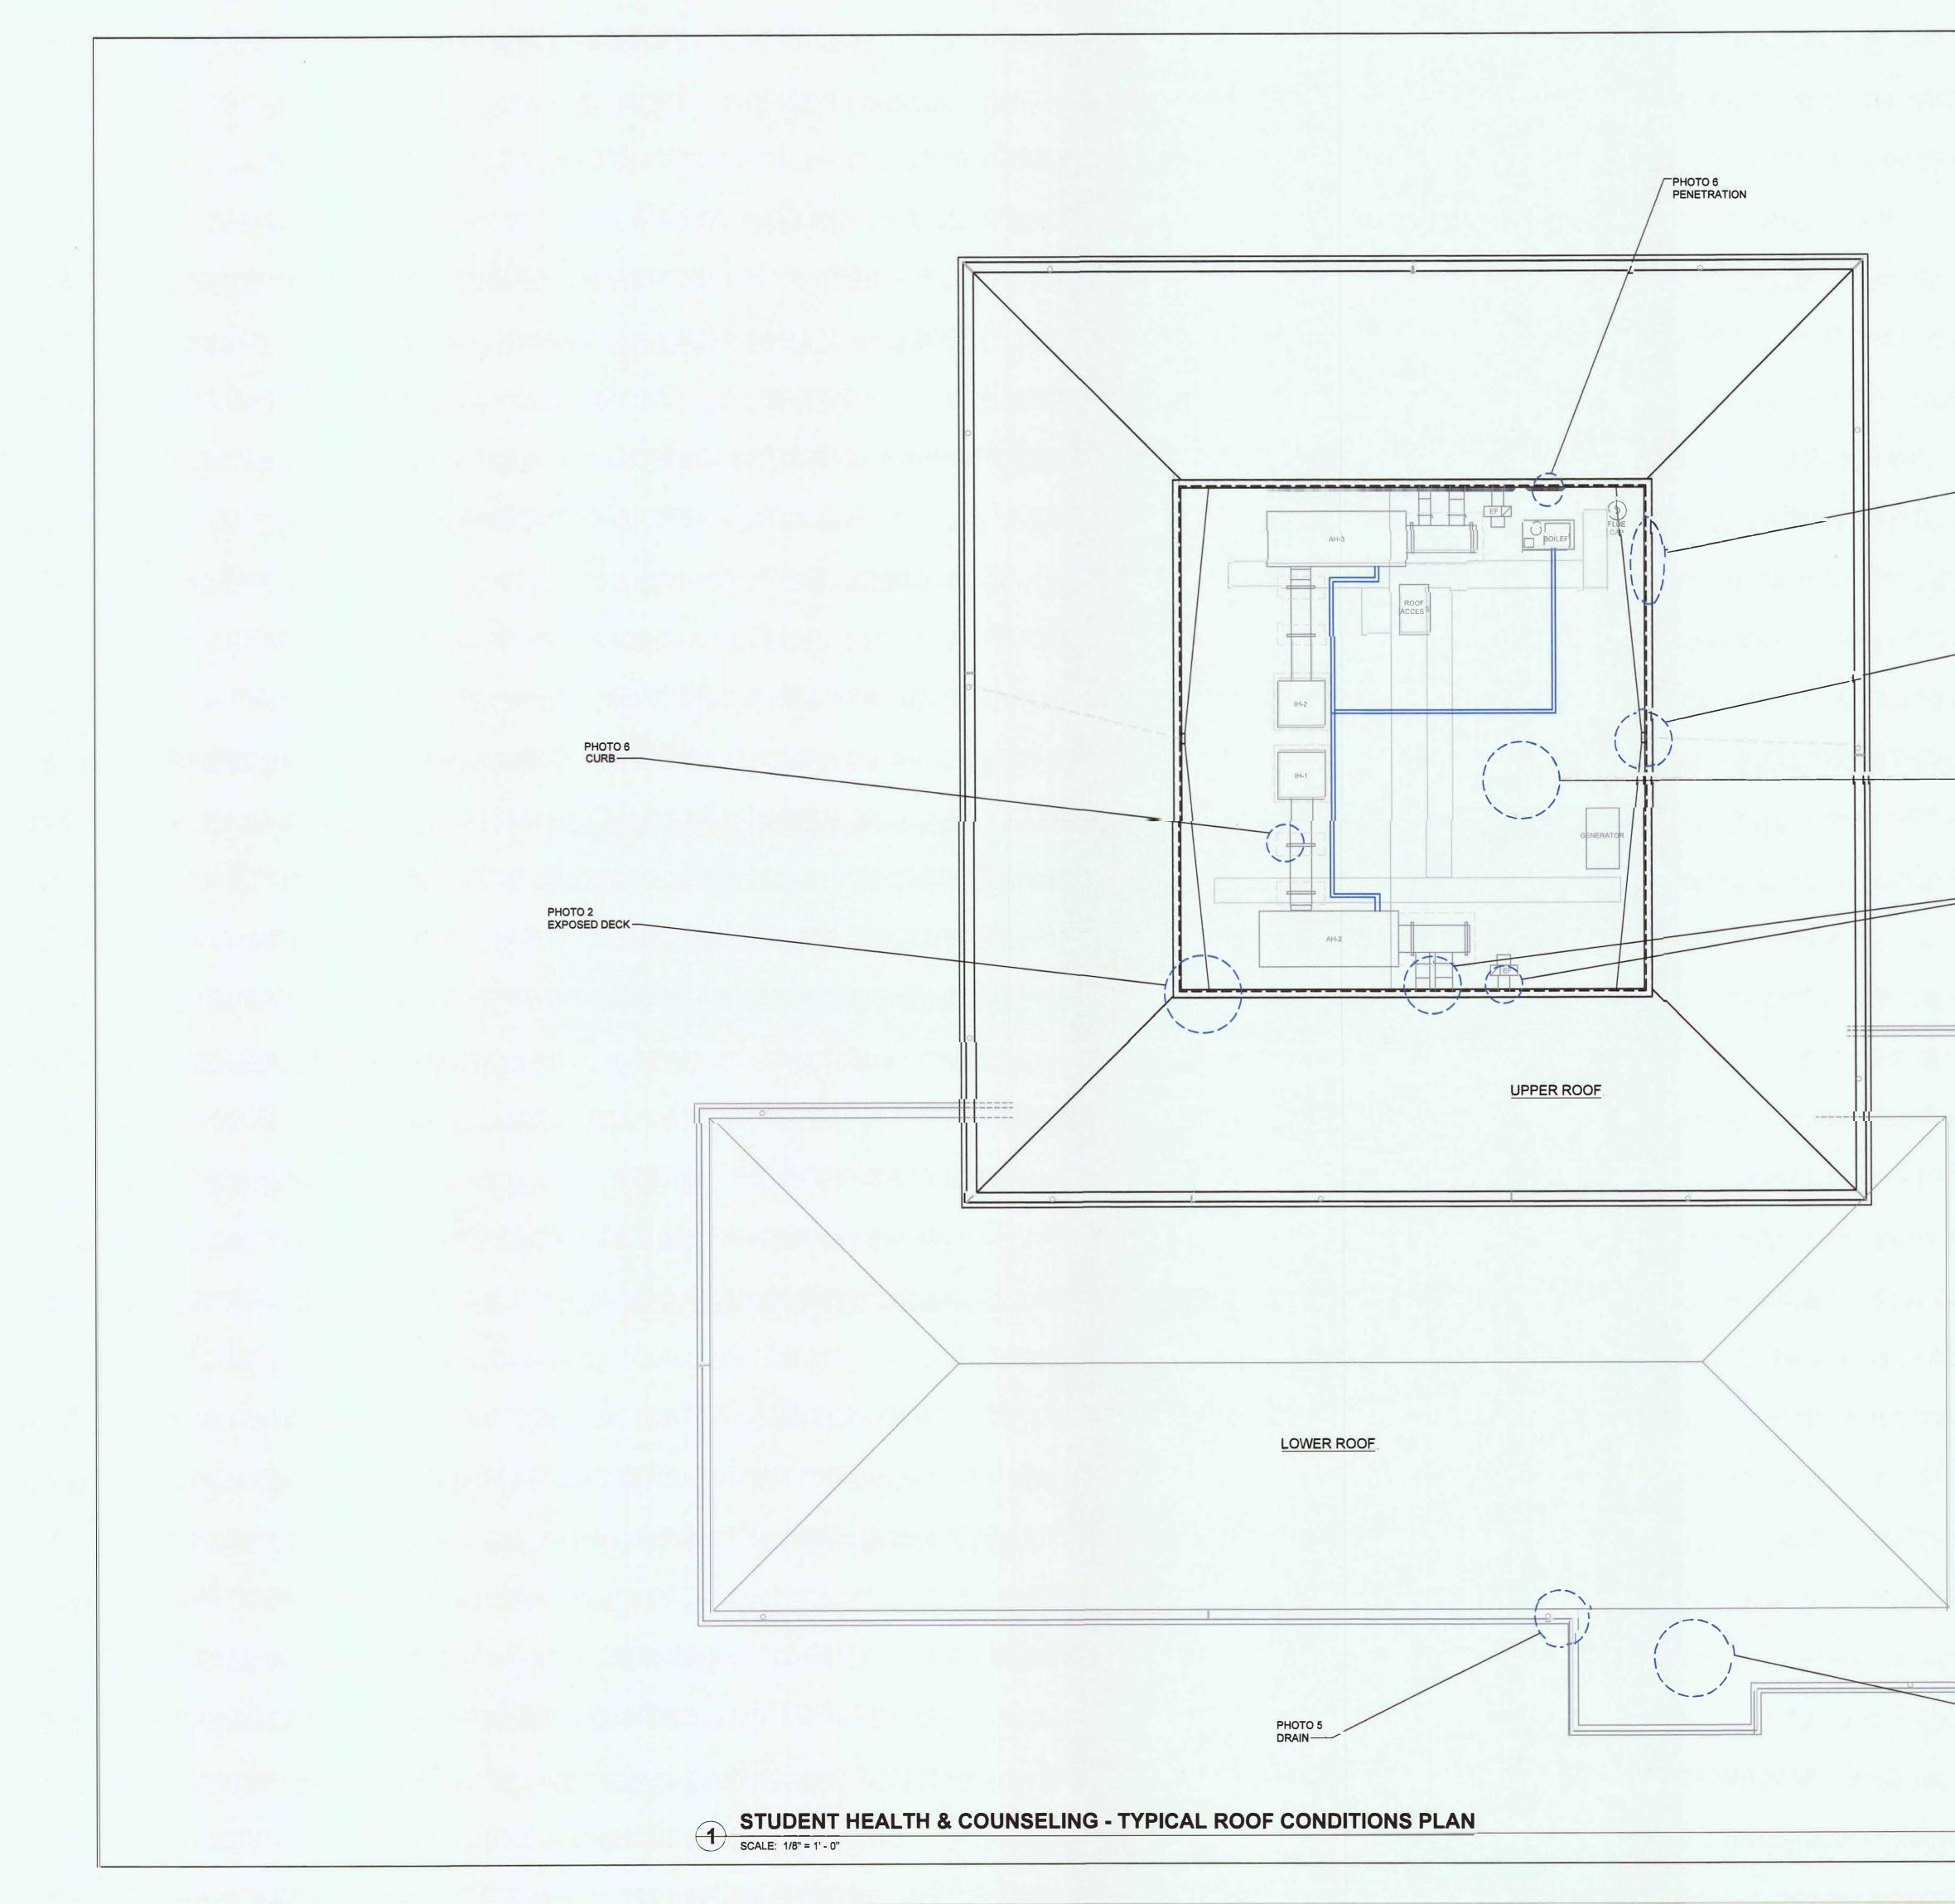

IFB #PW23-2 Exhibit F 9 of 10 H FACILITIES MANAGEMENT 1 HARPST STREET ARCATA, CA 95521 707 826-3646 PHOTO 3 DECK STUDENT HEALTH & COUNSEL NG (BLDG 042) S H & C ROOF REPAIR UPPER UTILITY WELL + LOWER SOUTH-EAST ENTRY & GUTTER -PHOTO 3 DRAIN - PHOTO 1 B.U.R. PHOTO 4 DUCTWORK & PENETRATION STATUS CONSTRUCTION DOCUMENTS BUILDING PERMIT APPROVAL This project has demonstrated conformance with applicable codes and standards established by statute and University policy. Based on this determination these docu 'APPROVED TR CONST IUC KASSIDY D. BANDUCCI Campus De Building Official California State Polytechnic University, Humboldt Date 2021/22-013 Other approvals 'as applicable: SFM Approval:\_\_\_\_\_ DSA Access Approval: Seismic Peer Review: Other:\_\_\_\_ CALIFORNIA STATE FIRE MARSHAL APPROVED Approval of this plan does not authorize or approve any omission or deviation from applicable regulations. Final approval is subject to field inspection. One set of approved plans shall be available on the projecties at all times. A = 14:10 Reviewed by: 4-14-22\_ PROJECT #: XPL257 W.O. #: \_\_\_\_\_ DRAWN BY: \_\_\_\_\_CKB\_ ISSUE DATE: APR. 07, 2022 REV: SHEET TITLE TYPICAL ROOF CONDITIONS PLAN PHOTO 2 B.U.R. SHEET A2.2 NORTH 4 of 5 sheets




NOTE: SEAL ALL CURBS, JACKS, PITCH POCKETS AND OTHER PENETRATIONS PRIOR TO NEW COATING

TYPICAL CURB CONDITION



TYPICAL PENETRATION @ VERTICAL SURFACE




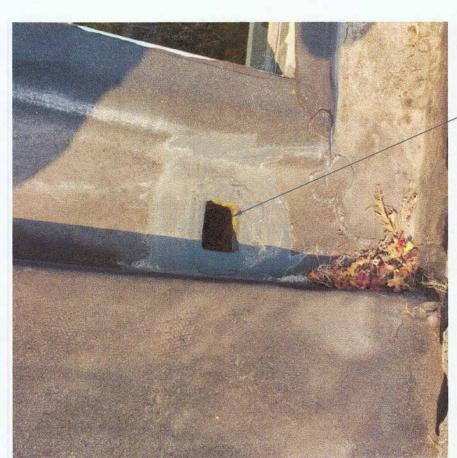

NOTE: CLEAN AND SEAL DRAIN AREAS PRIOR TO NEW COATING.

TYPICAL DRAIN



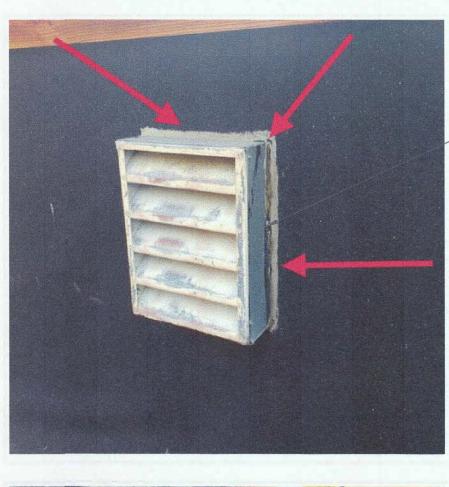

NOTE: SEAL ALL DUCT JOINTS AND OTHER PENETRATIONS PRIOR TO NEW COATING

- TYPICAL PENETRATION @ VERTICAL SURFACE

TYPICAL DUCTWORK CONDITION



### **TYPICAL DUCTWORK AND PENETRATIONS** 4 SCALE: NTS




NOTE: CLEAN AND SEAL DRAIN AREAS PRIOR TO NEW COATING.

TYPICAL DRAIN


NOTE: SEAL EXPOSED DECK. REMOVE TILE, INSTALL WATER AND ICE PEEL AND STICK UNDEERLAYMENT AND REINSTALL TILE PRIOR TO NEW COATING.

TYPICAL EXPOSED DECK CONDITION

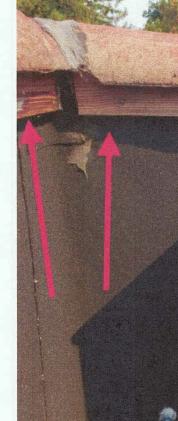



TYPICAL EXPOSED DECK AND LOWER ROOF 2 SCALE: NTS

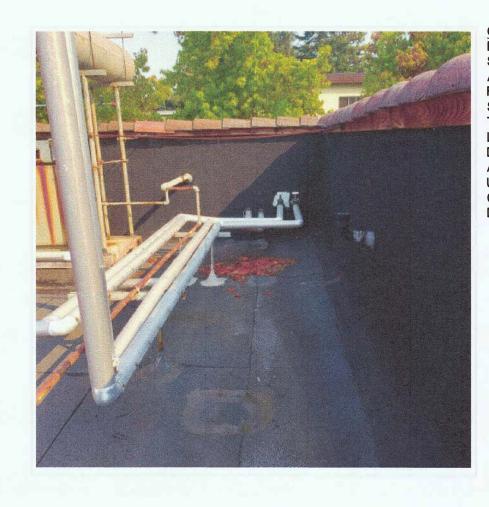

1 SCALE: NTS

TYPICAL EXPOSED DECK AND DRAIN SCALE: NTS

3

## **GENERAL ROOFING INFORMATION**

GENERAL ROOFING INFORMATION: ROOF SYSTEM IS A TYPICAL SPECULATIVE-GRADE BUILT-UP ROOF ASSEMBLY WITH A CAP SHEET. THE FIBERGLASS REINFORCEMENT AND CAP SHEET WERE SET IN SUCCESSIVE LAYERS OF TYPE III HOT ASPHALT WITH THE PLY SHEET LAID SHINGLE FASHION. WALL FLASHINGS ARE DUAL-LAYER BASE SHEET AND CAP SHEET APPLICATIONS. PENETRATION FLASHINGS UTILIZE LEAD VENTS WITH CURBED UNITS COVERED WITH A BASE AND CAP FLASHING DETAIL.

TYPICAL LOWER ROOF AREA

NOTE: SEAL EXPOSED DECK. REMOVE TILE, INSTALL WATER AND ICE PEEL AND STICK UNDEERLAYMENT AND REINSTALL TILE PRIOR TO NEW COATING.

TYPICAL EXPOSED DECK CONDITION

FACILITIES MANAGEMENT 1 HARPST STREET ARCATA, CA 95521 707 826-3646 HEALTH & COUNSELING (BLDG 042) S H & C ROOF REPAIR UPPER UTILITY WELL + /ER SOUTH-EAST ENTRY & GUTTER STUDENT | NER 2 STATUS CONSTRUCTION DOCUMENTS BUILDING PERMIT APPROVAL This project has demonstrated conformance with applicable codes and standards established by statute and APPROVED F OR CONSTRUCTION KASSIDY D, BANDUCCI Campus Deputy Building Official California State Polyte mnic University, Humboldt Date: 20. APP-1L. 2072 2021/22-01; Permit #:\_\_\_\_ Other approvals, as applicable: SFM Approval: DSA Access Approval: Salsmic Peer Review;\_\_\_\_ Other:\_\_\_\_ CALIFORNIA STATE FIRE MARSHAL APPROVED Approvel of this plan does not authorize Approver of this plan does not authorize or approve any omission or deviation from applicable regulations. Final approval is subject to field inspection. One set of approved plans shall be available on the project site at all times. Selas Reviewed by: 474-22 PROJECT #: XPL257 W.O. #: DRAWN BY: CKB ISSUE DATE: APR. 07, 2022 **REV**:

SHEET TITLE

TYPICAL

ROOF

CONDITIONS

PHOTOS

SHEET

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Exhibit F

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